



DETAILS AND SPECIFICATIONS SHOWN ON THESE PLANS ARE INTENDED TO COMPLIMENT THE PROJECT PLANS AND STANDARD DETAILS. IN CASE OF CONFLICT BETWEEN THESE PLANS AND OTHER SPECIFICATIONS, THE MORE RESTRICTIVE CASE APPLIES, UNLESS SPECIFICALLY OVERRIDDEN.

00477.00 1'=30' 1/4

00-477

File No.

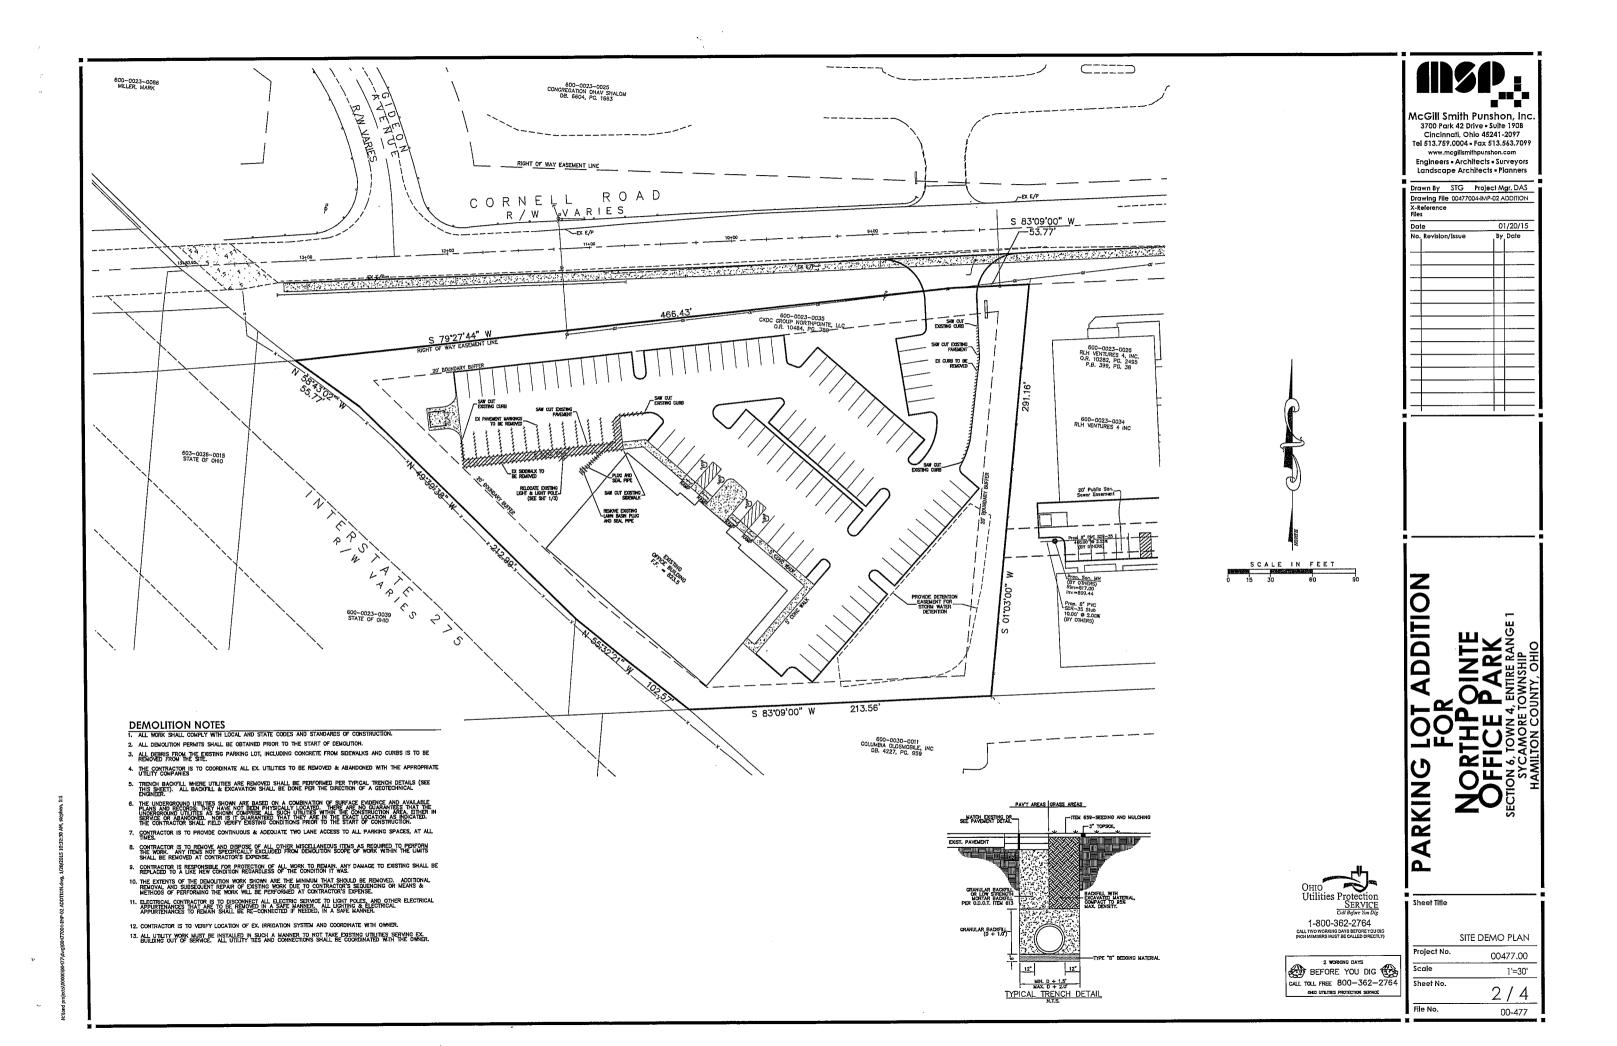

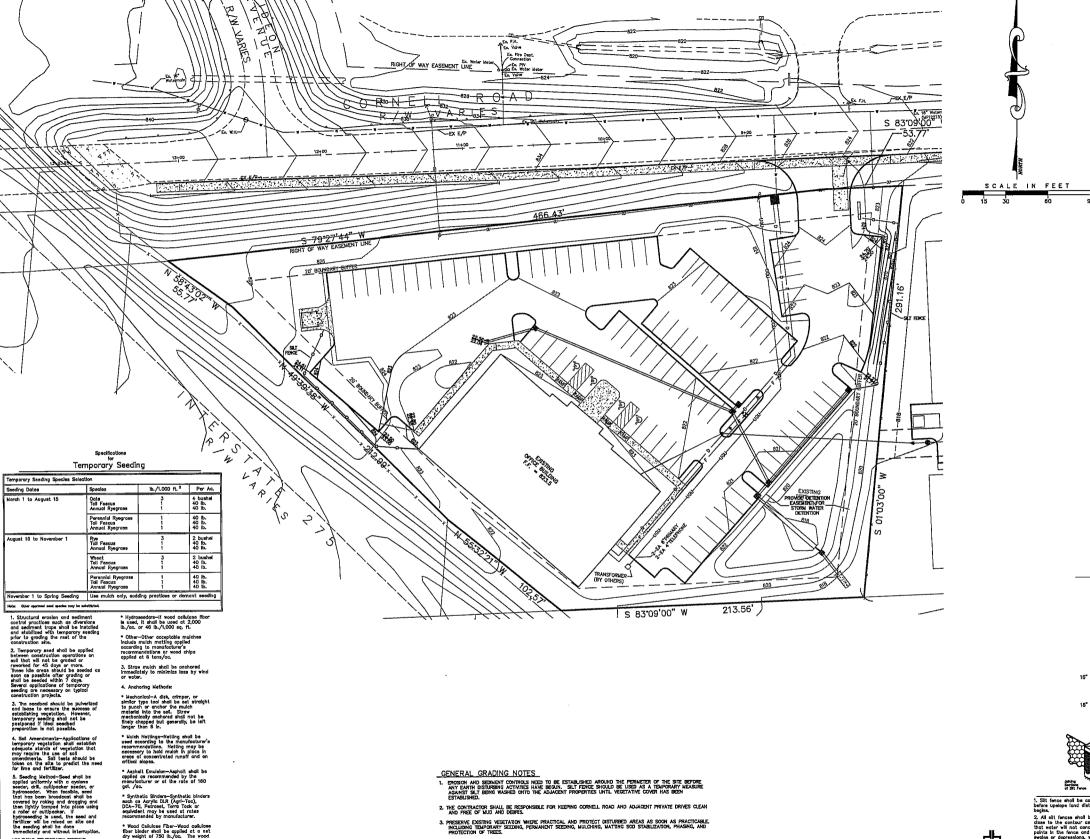

McGill Smith Punshon, Inc. 3700 Park 42 Drive - Suite 1908 Cincinnati, Ohio 45241-2097 Tel 513.759.0004 = Fax 513.563.7099 www.mcgilismithpunshon.com

Engineers - Architects - Surveyors Landscape Architects * Planners

Drawn By STG Project Mgr. DAS Drawing File 00477004-IMP-02 ADDITION X-Reference Files 01/20/15 Date By Date

ADDITION ARKING _`

File No.

Specifications for Silt Fence

SECTION

Prop Constanting Contract Cont

Level Contour No Slope

ELEVATION

ESTABLISH VEGETATION ON ALL BARE AREAS AS PER O.E.P.A. N.P.D.E.S. REGULATIONS. CONTRACTOR IS RESPONSIBLE FOR N.P.D.E.S. INSPECTIONS DURING CONSTRUCTION PERIOD.

Silt Frence

2. All sit forces shall be placed as takes to the contour or possible as that the contour or possible as the contour of 8 in. deep years or possible as the contour of 8 i

Sheet Title			
	GRADING PLAN		
Project No.	00477.00		
Scale	1'=30'		
Sheet No.	3 / 4		

00-477

PARK PARK ENTIRE RANG

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SECTION (

6. PARKING LOTS SHALL BE GRADED TO ASSURE POSITIVE FLOW TOWARDS THE STORM SEWER INLETS.

GRANULAR BACKFIL IS REQUIRED IN ALL PIPE TRENCHES LOCATED UNDER PAYEMENT OR SIDEWALKS. BACKFIL SHALL BE COMPACTED TO 100% STANDARD PROCTOR DENSITY AND TESTED BY APPROVED AGENT, UNLESS MOTED OTHERWISE.

* Strew-If strow is used, it shall be unrotted small-grain strow applied at least the strong strow applied at least 100 kg. (1,000 k

MULTIMO TEM-CRAYT SEEDING


1. Applications of temporary seeding
shall include muich that shall be
applied during or immediately after
seeding. Seedings mode during
aptimum seeding dates and with
floworable soil conditions and on very
flat areas may not need muich to
achieve adequate stabilization.

7. THE CONTRACTOR IS TO CONTRM ALL EXISTING UTILITY LOCATIONS AND PROTECT THEM FROM DAMAGE. IF DISCREPANCIES DAST, NOTIFY THE PROPER UTILITY COMPANY OR AGENCY, REJOCATION OF EXISTING UTILITIES WILL BE DONE IN ACCORDANCE WITH THE APPROPRIATE UTILITY COMPANY OR AGENCY RULES AND REGULATIONS.

9. THE CONTRACTOR SHALL BECOME COMPLETELY FAMILIAR WITH THE SOILS REPORT PREPARED BY THE GEOTECHNICAL ENGINEER - ALT & WITZIG ENGINEERS, INC.

3 SERVICE Call Before You Dig

1-800-362-2764

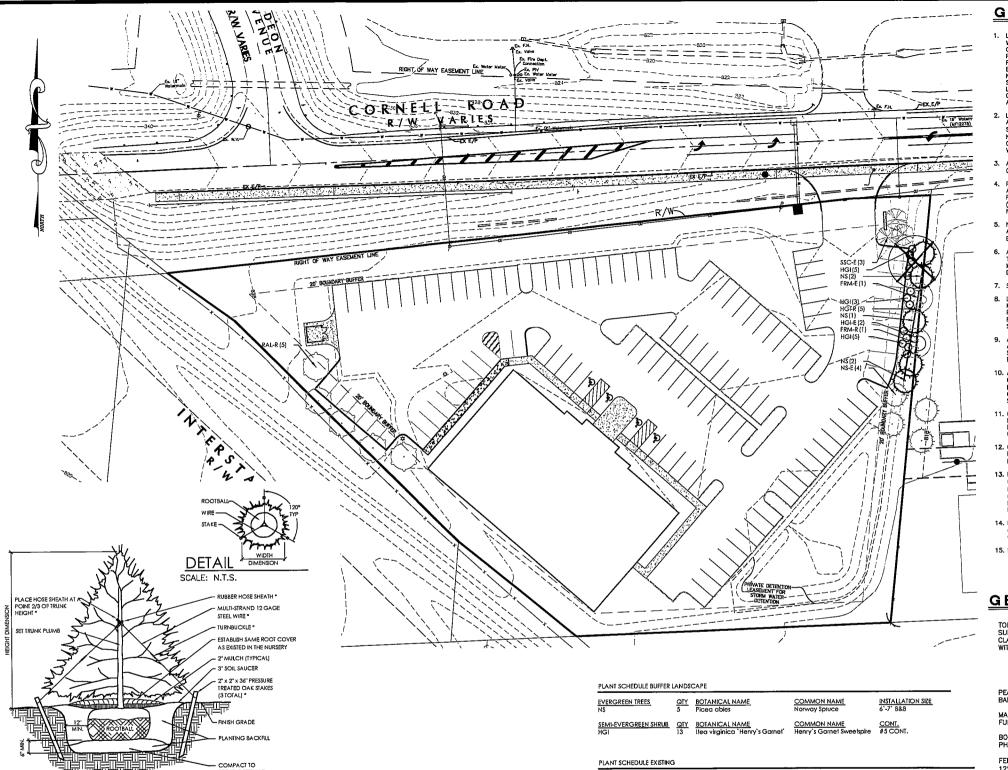

CUT AND REMOVE BURLAP FROM TOP 1/3 OF ROOTBALL
 IF CONTAINER IS USED, REMOVE CONTAINER AND LIGHTLY

HAND SCARIFY ALL SIDES OF THE ROOT SYSTEM.

FINISH GRADE

SCALE: N.T.S.

2. SHRUB SHALL BEAR SAME RELATION TO FINISH GRADE

EVERGREEN TREES NS-E	QTY 4	BOTANICAL NAME Picea abies	COMMON NAME Norway Spruce	INSTALLATION SIZE EXISTING
ORNAMENTAL TREES SSC-E	QTY 3	BOTANICAL NAME Malus x `Spring Snow`	COMMON NAME Spring Snow Crabapple	INSTALLATION SIZE EXISTING
SHADE TREES FRM-E	QTY 1	BOTANICAL NAME Acer rubrum `Firzam`	COMMON NAME Fireball Red Maple	INSTALLATION SIZE EXISTING
FRM-R	1	Acer rubrum 'Firzam' RELOCATED	Fireball Red Maple	EXISTING
RAL-R	5	Tilia americana 'Redmond' RELOCATED	Redmond American Linden	EXISTING
SEMI-EVERGREEN SHRUB HGI-E	QTY 2	BOTANICAL NAME Itea virginica `Henry's Garnet`	<u>COMMON NAME</u> Henry's Garnet Virginia Sweetspire	CONT. EXISTING
HGI-R	5	Itea virginica `Henry`s Garnet` RELOCATED	Henry's Garnet Sweetspire	EXISTING

GENERAL NOTES-PLANTING

- LANDSCAPE CONTRACTOR IS TO VERIFY LOCATIONS OF ALL UTILITIES WITH THE OWNER, OWNER'S REPRESENTATIVE, GENERAL CONTRACTOR, CONSTRUCTION MANAGER OR DESIGN BUILDER AND UTILITY COMPANIES PRIOR TO BEGINNING CONSTRUCTION. LANDSCAPE CONTRACTOR IS RESPONSIBLE FOR DETERMINING IN THE FIELD ACTUAL LOCATIONS AND LELVATIONS OF EXISTING UTILITIES, WHICHER INJOICATED ON PLANS OR NOT. LANDSCAPE CONTRACTOR MUST CALL THE UTILITIES PROTECTION SERVICE A WINIMUM OF 48 HOURS PRIOR TO CONSTRUCTION. LANDSCAPE CONTRACTOR SHALL BE FULLY RESPONSIBLE FOR DAMAGE OF UTILITY LINES. WHICH IS CAUSED BY THEIR ACTIONS OR THE ACTIONS OF THEIR CONSULTANTS.
- LANDSCAPE CONTRACTOR TO EXAMINE FINISH SURFACE, GRADE ACCURACY AND TOPSOIL FOR DEPTH AND QUALITY; REFER TO SPECIFICATIONS (IF APPLICABLE); IF CONDITIONS ARE UNSATISFACTORY, NOTIFY OWNER, OWNER'S REPRESENTATIVE, GENERAL CONTRACTOR, CONSTRUCTION MANAGER OR GESIGN BUILDER AND DO NOT BEGIN WORK UNTIL CONDITIONS HAVE BEEN CORRECTED.
- . AFTER INSTALLATION, REPAIR ALL DAMAGES MADE TO EXISTING CONDITIONS TO OWNER'S REPRESENTATIVE'S SATISFACTION.
- PLANT MATERIALS SHALL CONFORM TO THE STANDARDS OF THE AMERICAN NURSERY AND LANDSCAPE ASSOCIATION AND SHALL HAVE PASSED INSPECTION REQUIRED UNDER STATE REGULATIONS. CALL (202)—788—2900 TO DATAIN A COPY OF THE AMERICAN STANDARD FOR NURSERY STOCK BOOKLET.
- NURSERY STOCK IDENTIFICATION TAGS SHALL NOT BE REMOVED FROM ANY PLANTING PRIOR TO INSPECTION AND APPROVAL OF INSTALLATION BY THE OWNER'S REPRESENTATIVE.
- 6. ALL PLANTINGS TO BE CONTAINED WITHIN BARK MULCHED BED. ALL TREES LOCATED WITHIN LAWN AREAS TO BE CONTAINED WITH A 5' MULCH RING. BARK MULCH SHALL BE FINELY SHREDDED HARDWOOD, DARK IN COLOR.
- 7. SEED ALL DISTURBED LAWN AREAS THAT ARE NOT LANDSCAPED.
- 8. LANDSCAPE CONTRACTOR, GENERAL CONTRACTOR, CONSTRUCTION MANAGER OR DESION BUILDER IS RESPONSIBLE FOR MAINTAINING POSITIVE DRAINAGE IN LAWN AREAS. LANDSCAPE CONTRACTOR IS RESPONSIBLE FOR PLANT'S LIVABILITY. REFER TO FRONT END SPECIFICATIONS IF APPLICABLE.
- ANY LANDSCAPE CONTRACTOR RECOMMENDED SUBSTITUTIONS MUST BE APPROVED BY THE LANDSCAPE ARCHITECT. UNAPPROVED SUBSTITUTIONS SHALL BE REMOVED AND REPLACED WITH APPROPRIATE PLANTS.
- 10. A COMPLETE LIST OF PLANTS, INCLUDING A SCHEDULE OF SIZES, QUANTITIES, AND OTHER COMMENTS IS SHOWN ON THE DRAWINGS (IF REQUIRED). IN THE EVENT THAT QUANTITY DISCREPANCIES OR MATERI OMISSIONS OCCUR IN THE PLANT SCHEDULE, THE PLANTING PLANS SHALL GOVERN.
- 11. GENERAL CONTRACTOR, CONSTRUCTION MANAGER, DESIGN BUILDER OR LANDSCAPE CONTRACTOR IS RESPONSIBLE FOR COMPLIANCE WITH ALL FEDERAL, STATE AND LOCAL ORDINANCES AND SHALL MAKE CONSULTANTS AWARE OF THESE ORDINANCES.
- GENERAL CONTRACTOR, CONSTRUCTION MANAGER, DESIGN BUILDER OR LANDSCAPE CONTRACTOR TO COORDINATE CONSTRUCTION STAGING AND MATERIAL STOCKPILING WITH THE OWNER OR OWNER'S REPRESENTATIVE.
- 13. DURING ALL PHASES OF CONSTRUCTION ACTIVITY, IF THE LANDSCAPE CONTRACTOR OR THEIR SUBS ENCOUNTER ANY "SOLID WASTE MATERIAL" (EXCLUDING CLEAN HARD FILL) THE GENERAL CONTRACTOR, CONSTRUCTION MANAGER, DESIGN BUILDER, OWNER OR OWNER'S REPRESENTATIVE SHALL BE CONTACTED IMMEDIATELY FOR FURTHER DIRECTION.
- 14. LANDSCAPE CONTRACTOR SHALL CLEAN STREETS OF MUD AND DEBRIS GENERATED BY THEIR CONSTRUCTION ACTIVITIES OR THEIR SUB'S CONSTRUCTION ACTIVITIES, PURSUANT WITH LOCAL CODE REQUIREMENTS.
- 15. LANDSCAPE CONTRACTOR TO COORDINATE WITH THE GENERAL CONTRACTOR, CONSTRUCTION MANAGER, DESIGN BUILDER, OWNER OR OWNER'S REPRESENTATIVE TO PROVIDE FOR APPROPRIATE CARE OF EXISTING PLANT MATERIAL AND NEWLY LANDSCAPED AREAS DURING CONSTRUCTION.

GENERAL NOTES-PLANTMIX

TOPSOIL: FERTILE, FRIABLE NATURAL TOPSOIL OF LOAMY CHARACTER, WITHOUT ADMIXTURE OF SUBSOIL MATERIAL, OBTAINED FROM A WELL-DRAINED ARABLE SITE, REASONABLY FREE FROM CLAY, LUMPS, COARSE SANDS, STONES, PLANTS, ROOTS, STICKS, AND OTHER FOREIGN MATERIALS, WITH ACIDITY RANGE BETWEEN pH 6.0 AND 6.8.

IDENTIFY SOURCE LOCATION OF TOPSOIL PROPOSED FOR USE ON THE PROJECT. PROVIDE TOPSOIL FREE OF SUBSTANCES HARMFUL TO THE PLANTS, WHICH WILL BE

PEAT MOSS: BROWN TO BLACK IN COLOR, WEED AND SEED FREE GRANULATED RAW PEAT OR BALED PEAT, CONTAINING NOT MORE THAN 9% MINERAL ON A DRY BASIS.

MANURE: STERILIZED COW OR DEHYDRATED HORSE MANURE, SHREDDED, WEED AND SEED FREE. FURNISH IN BAGS OR BULK.

BONE MEAL: RAW, FINELY GROUND, COMMERCIAL GRADE, MINIMUM 3% NITROGEN, 205

FERTILIZER: COMMERCIALLY APPROVED 12-12-12 (12% NITROGEN, 12% PHOSPHORIC ACID, AND 12% POTASH BY WEIGHT). 1/4 OF NITROGEN IN THE FORM OF NITRATES; 1/4 IN THE FORM OF AMMONIA SALT, AND 1/2 IN THE FORM OF ORGANIC NITROGEN.

PROVIDE PRE-MIXED PLANTING MIXTURE FOR USE AROUND THE ROOT BALL/ROOTS OF THE PLANTS CONSISTING OF 5 PARTS TOPSOIL, 1 PART PEAT MOSS, 1 PART MANURE, 10 LBS. FERTILIZER (PER CUBIC YARD) AND 2 1/3 LBS. OF BONE MEAL (PER CUBIC YARD).



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1'=30'

McGill Smith Punshon, Inc

3700 Park 42 Drive = Suite 190B Tel 513 759 0004 Fax 513 563 7099

Engineers - Architects - Surveyors

Landscape Architects - Planners

rawn By DJF Project Mgr. DAS

X-Referenc

00477006-PLA-02

01/20/15

00477004-IMP-02 ADDITION

EVERGREEN TREE STAKING & GUYING SHRUB PLANTING

IO. REMOVE STAKES I YEAR AFTER PLANTING.

1. IF NOT READILY APPARENT, LOCATE TRUNK FLARE BY REMOVING TWINE, BURLAP, AND EXCESS SOIL.

6. BACKFILL PLANTING HOLE WITH PLANT MIX (SEE GENERAL NOTES), AND THOROUGHLY WATER

DIG TREE HOLE AT LEAST TWO TIMES WIDER THAN THE ROOT BALL, WITH SIDES SLOPED TO AN UNEXCAVATED OR
FRN BASE. DIG HOLE TO A DEPTH SO THE LOCATED TRUNK FLARE, AT THE FIRST ORDER LATERAL ROOT, WILL BE AT
FINISHED GRADE.

3. LIFTING ONLY FROM THE BOTTOM OF THE ROOT BALL, POSITION TREE ON FIRM PAD SO THAT IT IS STRAIGHT AND TOP OF FLARE IS LEVEL WITH THE SURROUNDING SOIL.

8. MULCH ENTIRE PLANTING SURFACE WITH COMPOSTED BARK MULCH APPUED NO LESS THAN TWO INCHES (2") DEEP AND NO MORE THAN THREE INCHES (3") DEEP, LEAVING THREE INCHES (3") ADJACENT TO THE TREE TRUNK FREE OF

9.° EVERGREEN TREES WITH 2" CAUPER OR SMALLER SHALL BE STAKED. EVERGREEN TREES HAVING A HEIGHT OF 7" OR GREATER SHALL BE STAKED.

4. REMOVE ALL TWINE FROM ROOT BALL. IF PRESENT, REMOVE AND DISCARD TOP 3" OF BURLAP FROM THE ROOT WITH CLEAN, SHARP PRUNING TOOLS, PRUNE OFF ANY SECONDARY/ADVENTITIOUS, GIRDLING, AND POTENTIAL GIRDLING ROOTS.