



VICINITY MAP

SCALE: 1" = 1,000"

PARCEL INFORMATION

EXISTING PARCELS TO BE RECLASSIFIED TO "EE" PLANNED RETAIL

PARCEL NUMBER 600-0211-0105 600-0211-0131 600-0211-0161

600-0211-0210 0.16 ACRES

JAMES G. CHANTILAS 7221 CHETBERT DRIVE CINCINNATI, OH 45236

PARCELS TO REMAIN "E" RETAIL

PARCEL NUMBER 600-0211-0155

OWNER
CHANTIAN CINCT PROPERTIES, LLC
//O7 MONTGOMERY ROAD
CINCINNATI, OH 45236

L & P COMPANY 7707 MONTGOMERY ROAD CINCINNATI, OH 45236

GENERAL NOTES

EXISTING ZONING:

"C" SINGLE FAMILY RESIDENTIAL, "O" OFFICE

"EE" PLANNED RETAIL PROPOSED ZONING:

0.682 ACRES

NET AREA OF PROPOSED REZONE: GROSS AREA OF PROPOSED REZONE:

RIGHTS-OF-WAY SHOWN ARE PUBLIC.

PROPOSED LAND USE:

RESTAURANT & RETAIL USE AND NEW APPURTENANT PARKING AREA

INDEX OF SHEETS

ZONING PLAT

EXISTING FEATURES PLAN PROPOSED FEATURES PLAN


PRELIMINARY GRADING PLAN

L1 LANDSCAPE PLAN
L2 LANDSCAPE DETAILS & DUMPSTER DETAILS
L3 PHOTOMETRIC PLAN


PROPOSED ZONE CHANGE SKYLINE CHILI - KENWOOD

SECTION 13, TOWN 4, ENTIRE RANGE 1 SYCAMORE TOWNSHIP, HAMILTON COUNTY, OHIO


ZONING PLAT

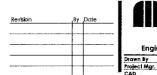

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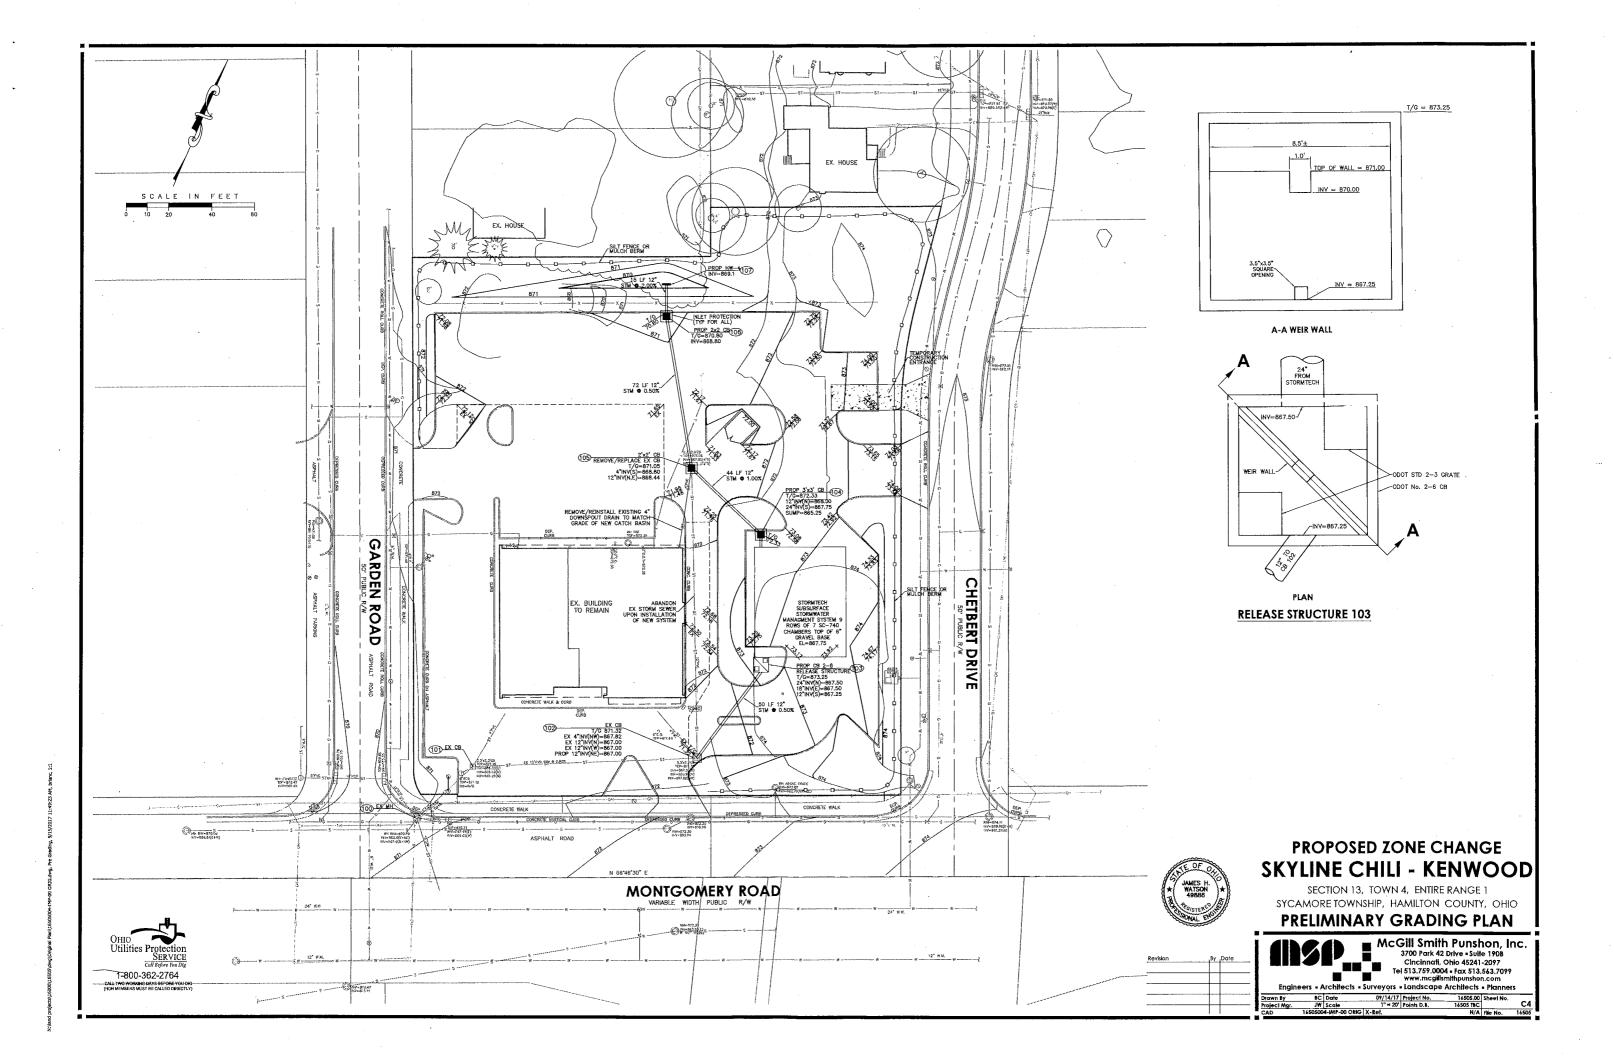
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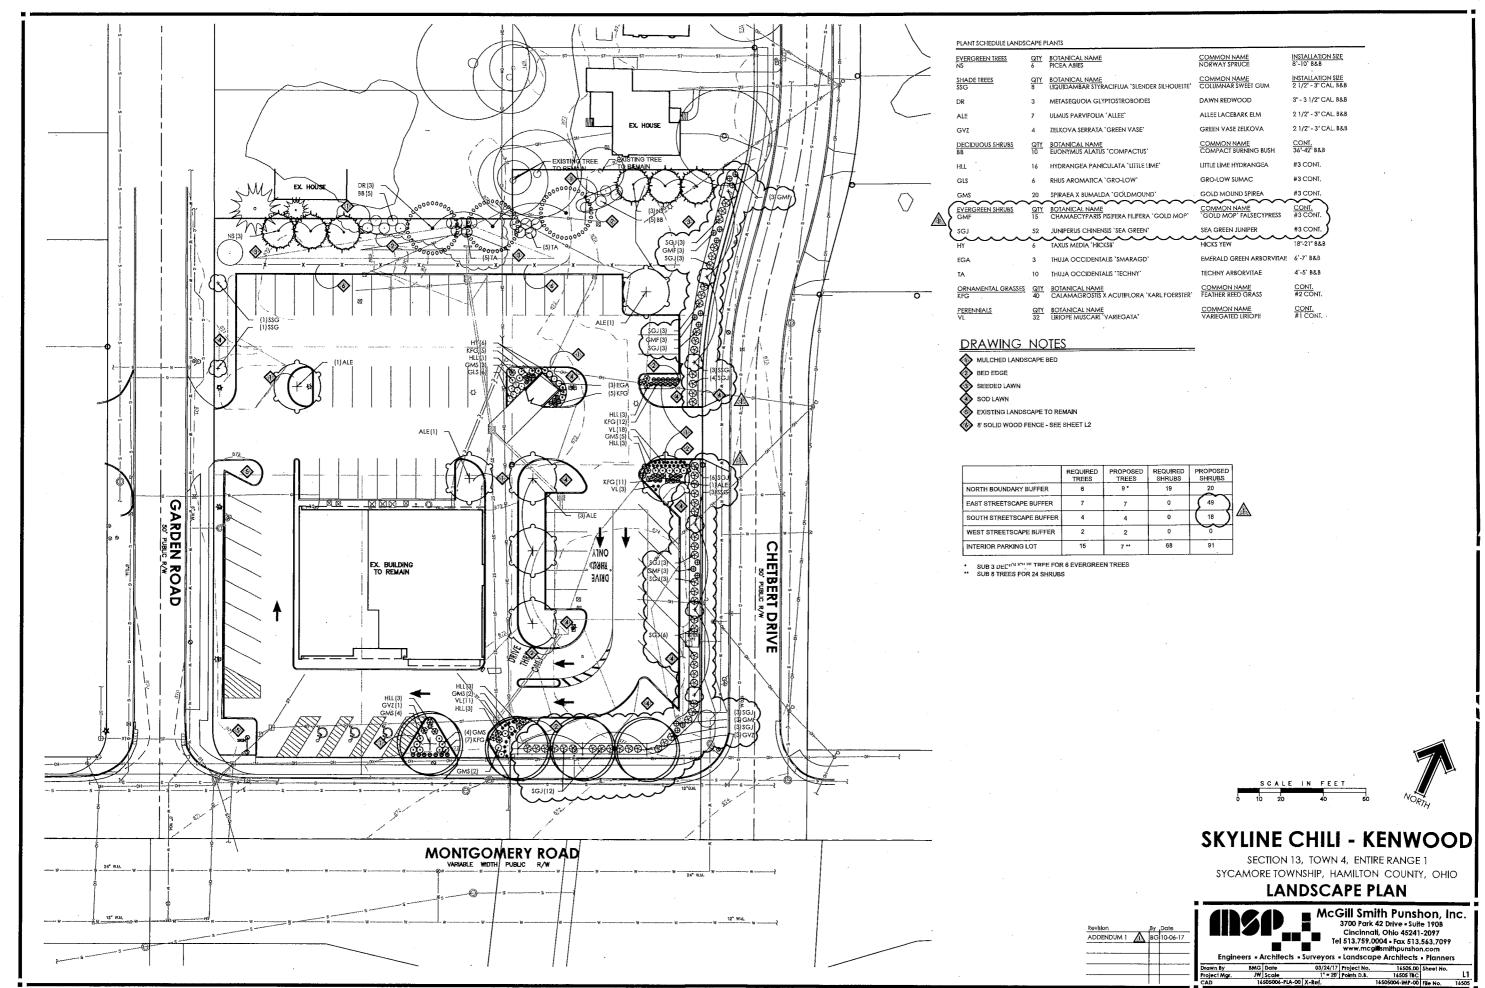


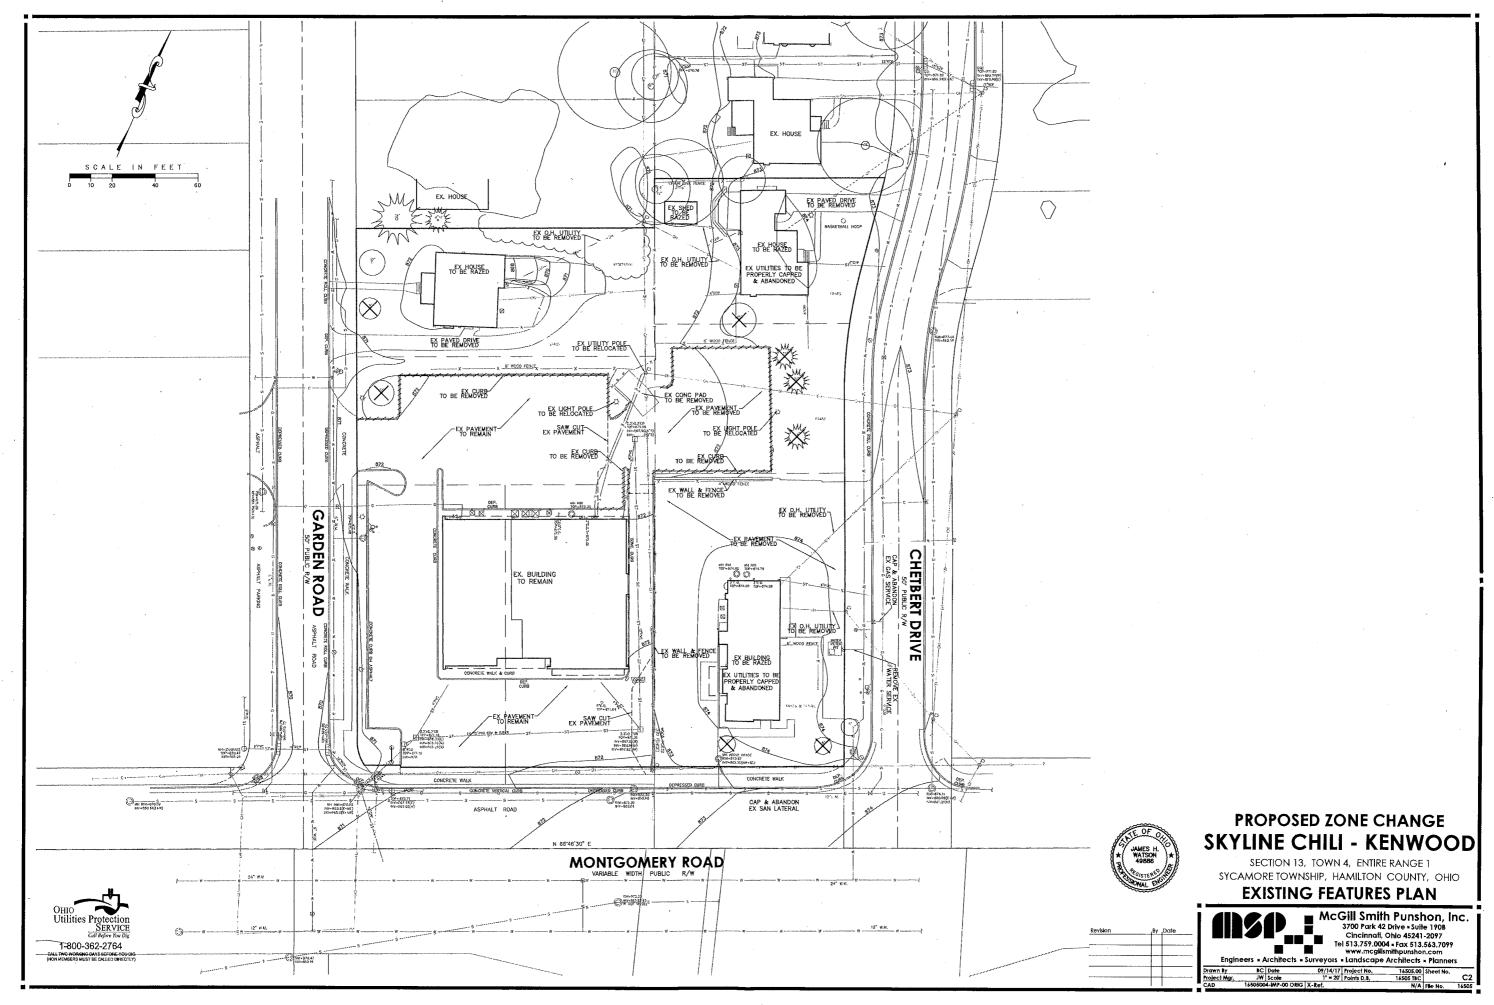By Date JW 10/06/17 Revision #1


 Drawn By
 BC
 Date
 D9/14/17
 Project No.
 16505.00
 Sheel No.

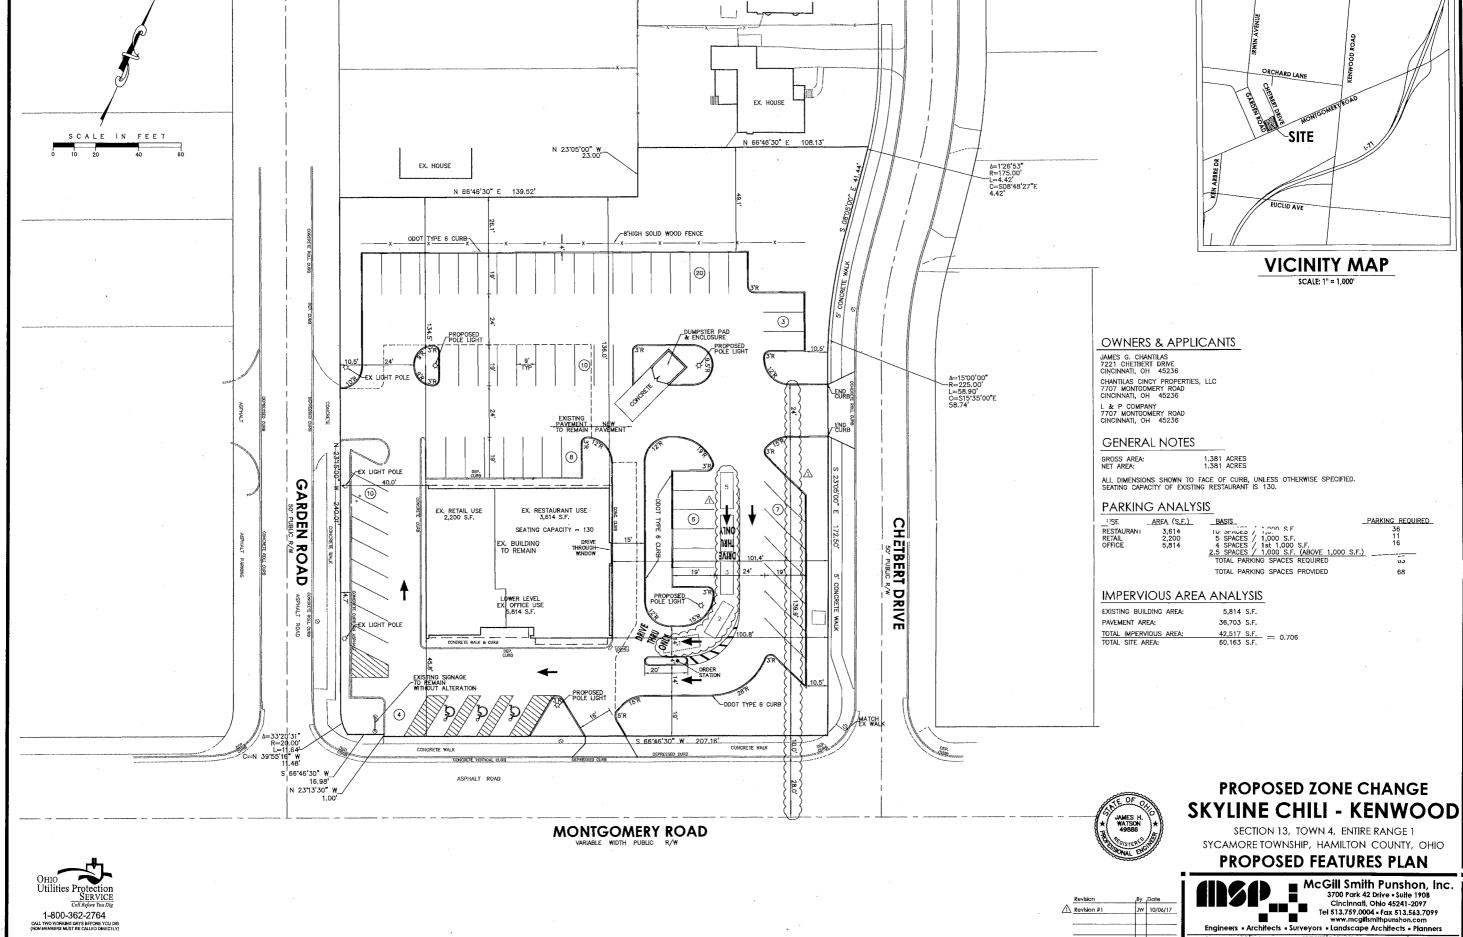 Project Mgr.
 JW Scale
 1°=20
 Points D.B.
 16505 TBC
 N/A
 N/A





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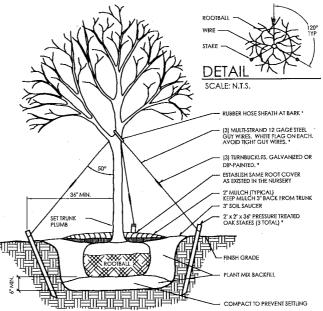
INSTALL HOLES IN CONCRETE

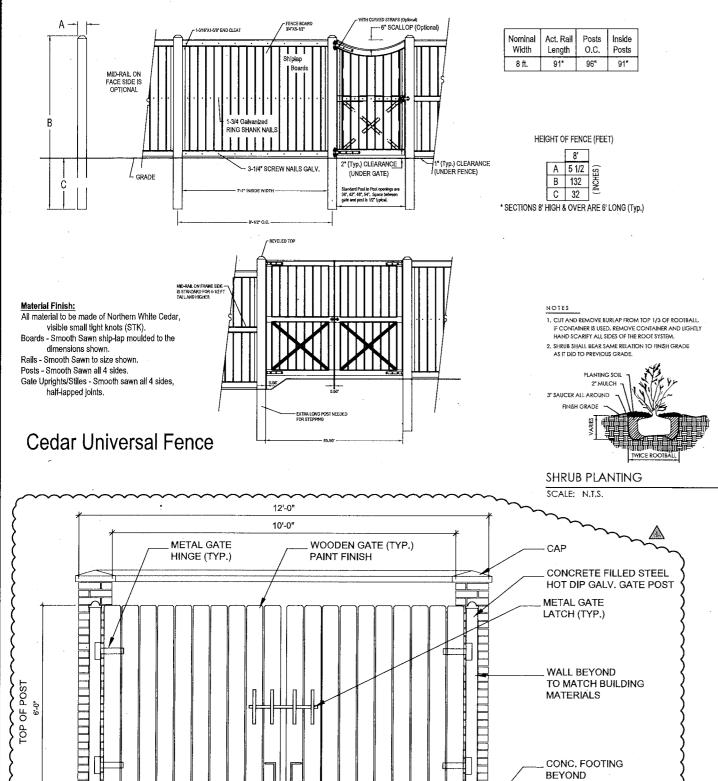FOR 1" DIA, HOT DIP

BRICK TO MATCH EXISTING BUILDING.
 ALL EXPOSED STEEL TO BE HOT DIP GALV.

Brick Dumpster Enclosure

GALV. BOLTS ON GATES



NOTES

- IF NOT READILY APPARENT, LOCATE TRUNK FLARE BY REMOVING TWINE, BURLAP, AND EXCESS SOIL.
- DIG TREE HOLE AT LEAST TWO TIMES WIDER THAN THE ROOT BALL, WITH SIDES SLOPED TO AN UNEXCAVAIGED OR FIRM BASE, DIG HOLE TO A DEPTH SO THE LOCATED TRUNK FLARE, AT THE FIRST ORDER LATERAL ROOT, WILL BE AT TRUSHED GRADE.
- LIFTING ONLY FROM THE BOTTOM OF THE ROOT BALL, POSITION TREE ON FIRM PAD SO THAT IT IS STRAIGHT AND TOP OF FLARE IS LEVEL WITH THE SURROUNDING SOIL.
- REMOVE ALL TWINE FROM ROOT BALL. IF PRESENT, REMOVE AND DISCARD THE TOP 3" OF BURIAP FROM THE ROOT BALL.
- WITH CLEAN, SHARP PRUNING TOOLS, PRUNE OFF ANY SECONDARY/ADVENTITIOUS, GIRDLING, AND POTENTIAL GIRDLING ROOTS.
- 6. PACKFILL PLANTING HOLE WITH PLANT MIX. (SEE GENERAL NOTES), AND THOROUGHLY WATER.
- 7. MULCH ENTIRE FLANIING SURFACE WITH COME OF THE BRANK PLANIES AND LESS THAN TWO INCHES (27) DEEP AND NO MORE THAN THREE INCHES (37) DEEP, LEAVING THREE INCHES (3) ADJACENT TO THE TREE TRUIK FREE OF MULCH.
- 8. STAKE DECIDUOUS TREES WITH A 2 1/2" OR GREATER CAUPER.
- 9. REMOVE STAKES 1 YEAR AFTER PLANTING.

DECIDUOUS TREE STAKING & GUYING


SCALE: N.T.S.

GENERAL NOTES - PLANTING

- LIANDSCAPE CONTRACTOR TO VERREY LOCATIONS OF ALL UTILITIES WITH THE OWNER, OWNERS
 REPRESENTATIVE, GENERAL CONTRACTOR, CONSTRUCTION, MANAGER OR DESIGN BULDER AND UTILITY
 COMPANIES PROT TO BEGINNING CONSTRUCTION, LANDSCAPE CONTRACTOR IS RESPONSIBLE FOR
 DETERMINING IN THE FIELD ACTUAL LOCATIONS AND ELEVATIONS OF EXITING UTILITIES, WHEHER INDICATED ON
 PLANS OR NOT, LANDSCAPE CONTRACTOR MUST CALL THE UTILITIES PROTECTION SERVICE A MINIMUM OF 48
 HOURS PROTO TO CONSTRUCTION. LANDSCAPE CONTRACTOR SHALL BE FULLY RESPONSIBLE FOR DAMAGE OF
 UTILITY LINES, WHICH IS CAUSED BY THEIR ACTIONS OR THE ACTIONS OF THEIR CONSULTANTS.
- IANDSCAPE CONTRACTOR TO EXAMINE FINISH SURFACE, GRADE ACCURACY AND TOPSOIL FOR DEPITH AND
 QUALITY: REFER TO SPECIFICATIONS; IF APPLICABLES; IF CONDITIONS ARE UNSATISFACTORY, NOTIFY OWNER,
 OWNERS REPRESENTATIVE, GENERAL CONTRACTOR, CONSTRUCTION MANAGER OR DESIGN BUILDER AND DO
 NOT BEGIN WORK UNITL CONDITIONS HAVE REEN CORRECTED.
- AFTER INSTALLATION, REPAIR ALL DAMAGES MADE TO EXISTING CONDITIONS TO OWNER'S REPRESENTATIVE'S SATISFACTION.
- PLANT MATERIALS SHALL CONFORM TO THE STANDARDS OF THE AMERICAN NURSERY AND LANDSCAPE
 ASSOCIATION AND SHALL HAVE PASSED INSPECTION REQUIRED UNDER STATE REGULATIONS. CALL (202)-789-2900
 TO OBTAIN A COPT OF THE AMERICAN STANDARD FOR NURSER'S STOCK REDOCKET.
- NURSERY STOCK IDENTIFICATION TAGS SHALL NOT BE REMOVED FROM ANY PLANTING PRIOR TO INSPECTION AND APPROVAL OF INSTALLATION BY THE OWNER'S REPRESENTATIVE.
- ALL PLANTINGS TO BE CONTAINED WITHIN BARK MULCHED BED. ALL TREES LOCATED WITHIN LAWN AREAS TO BE CONTAINED WITH A 5" MULCH RING. BARK MULCH SHALL BE FINELY SHREDDED HARDWOOD, DARK IN COLOR.
- 7, SEED ALL DISTURBED LAWN AREAS THAT ARE NOT LANDSCAPED.

GRADE (VARIES)

- LANDSCAPE CONTRACTOR, GENERAL CONTRACTOR, CONSTRUCTION MANAGER OR DESIGN BUILDER IS RESPONSIBLE FOR MAINTAINING POSITIVE ORAINAGE IN LAWN AREAS, LANDSCAPE CONTRACTOR IS RESPONSIBLE FOR PLANTS UNABLITY. REFER TO I FROM TEO SPECIFICATIONS IF APPLICABLE.
- ANY LANDSCAPE CONTRACTOR RECOMMENDED SUBSTITUTIONS MUST BE APPROVED BY THE LANDSCAPE ARCHITECT. UNAPPROVED SUBSTITUTIONS SHALL BE REMOVED AND REPLACED WITH APPROPRIATE PLANTS.
- 10. A COMPLETE LIST OF PLANTS, INCLUDING A SCHEDULE OF SIZES, QUANTITIES, AND OTHER COMMENTS IS SHOWN ON THE DRAWNINGS (IF REQUIRED). IN THE EYENT THAT QUANTITY DECREPANCIES OR MATERIAL OMISSIONS OCCUR IN THE PLANT SCHEDULE. THE PLANTING PLANS SHALL GOVERN.
- GENERAL CONTRACTOR, CONSTRUCTION MANAGER, DESIGN BUILDER OR LANDSCAPE CONTRACTOR B RESPONSIBLE FOR COMPILANCE WITH ALL FEDERAL, STATE AND LOCAL ORDINANCES AND SHALL MAKE CONSULTAINS SWARE OF INEED CONSULTANCES.
- GENERAL CONTRACTOR, CONSTRUCTION MANAGER, DESIGN BUILDER OR LANDSCAPE CONTRACTOR TO COORDINATE CONSTRUCTION STAGING AND MATERIAL STOCKPILING WITH THE OWNER OR OWNERS REPRESENTATIVE.
- 13. DURING ALL PHASES OF CONSTRUCTION ACTIVITY, IF THE LANDSCAPE CONTRACTOR OR THEIR SUBS ENCOUNTER ANY "SOLID WASTE MATERIAL" (EXCLUDING CLEAN HARD FILL) THE GENERAL CONTRACTOR, CONSTRUCTION MANAGER, DESIGN BUILDER, OWNER OR OWNERS REPRESENTATIVE SHALL BE CONTACTED IMMEDIATELY FOR FURTHER DIRECTION.
- 14. LANDSCAPE CONTRACTOR SHALL CLEAN STREETS OF MUD AND DEBRIS GENERATED BY THEIR CONSTRUCTION ACTIVITIES OR THEIR SUB'S CONSTRUCTION ACTIVITIES, PURSUANT WITH LOCAL CODE REQUIREMENTS.
- 15. LANDSCAPE CONTRACTOR TO COORDINATE WITH THE GENERAL CONTRACTOR, CONSTRUCTION MANAGER, DESIGN BUILDER, OWNER OR OWNERS REPRESENTATIVE TO PROVIDE FOR APPROPRIATE CARE OF EXISTING PLAN MATERIAL AND NEWLY LANDSCAPED AREAS DURING CONSTRUCTION.
- STREET TREE LOCATIONS TO BE COORDINATED WITH DRIVEWAY, FIRE HYDRANT, STREET LIGHT LOCATIONS AND OTHER UTILITIES AS REQUIRED.

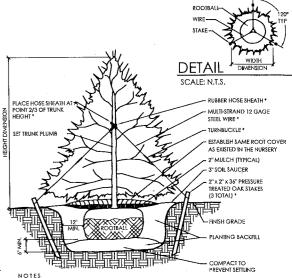

1. IF NOT READILY APPARENT, LOCATE TRUNK FLARE BY REMOVING TWINE, BURLAP, AND EXCESS SOIL

- DIG TREE HOLE AT LEAST TWO TIMES WIDER THAN THE ROOT BALL, WITH SIDES SLOPED TO AN UNEXCAVATED OR RIBM BASE. DIG HOLE TO A DEPTH SO THE LOCATED TRUNK FLARE, AT THE FIRST ORDER LATERAL ROOT, WILL BE AT FINSHED GRADE.
- 3. LIFTING ONLY FROM THE BOTTOM OF THE ROOT BALL, POSITION TREE ON FIRM PAD SO THAT IT IS STRAIGHT AND TOP OF FLARE IS LEVEL WITH THE SURROUNDING SOIL.
- 4. REMOVE ALL TWINE FROM ROOT BALL. IF PRESENT, REMOVE AND DISCARD TOP 3" OF BURLAP FROM THE ROOT BALL
- WITH CLEAN, SHARP PRUNING TOOLS, PRUNE OFF ANY SECONDARY/ADVENTITIOUS, GIRDLING, AND POTENTIAL GIRDLING ROOTS.
- 6. BACKFILL PLANTING HOLE WITH PLANT MIX (SEE GENERAL NOTES), AND THOROUGHLY WATER
- 7. PROVIDE WATER CRYSTALS PER MANUFACTURER'S RECOMMENDATION.
- MUICH ENTIRE PLANTING SUMMACS WITH COMPOSTED BARK MUICH APPLIED NO LESS THAN TWO INCHES (2") DEEP AND NO MORE THAN THREE INCHES (3") DEEP, LEAVING THREE INCHES (3") ADJACENT TO THE TREE TRUNK FREE OF MUICH.
- 9. EVERGREEN TREES WITH 2" CALIPER OR SMALLER SHALL BE STAKED, EVERGREEN TREES HAVING A HEIGHT OF 7" OR GREATER SHALL BE STAKED.

10. REMOVE CYAKES I YEAR AFTER PLANTING.

EVERGREEN TREE STAKING & GUYING

SCALE: N.T.S.

GENERAL NOTES - PLANT MIX

TOPSOIL: FERTILE, FRIABLE NATURAL TOPSOIL OF LOAMY CHARACTER, WITHOUT ADMIXTURE OF SUBSOIL MATERIAL, OSTAINED FROM A WELL-DRAINED ARABLE SITE, REASONABLY FREE FROM CLAY, LUMRS, COARSE SANDS, STONES, PLANTS, ROOTS, STICKS, AND OTHER FOREIGN MATERIALS, WITH ACIDITY RANGE BETWEEN PH 6.0 AND 6.8.

DENTIFY SOURCE LOCATION OF TOPSOIL PROPOSED FOR USE ON THE PROJECT,
 PROVIDE TOPSOIL FREE OF SUBSTANCES HARMFUL TO THE PLANTS, WHICH WILL BE GROWN IN THE SOIL.

PEAT MOSS: BROWN TO BLACK IN COLOR, WEED AND SEED FREE GRANULATED RAW PEAT OR BALED PEAT, CONTAINING NOT MORE THAN 9% MINERAL ON A DRY BASIS,

MANURE: STERILIZED COW OR DEHYDRATED HORSE MANURE, SHREDDED, WEED AND SEED FREE. FURNISH IN BAGS OR BULK.

BONE MEAL: RAW, FINELY GROUND, COMMERCIAL GRADE, MINIMUM 3% NITROGEN, 205 PHOSPHOROUS.


FERTILIZER: COMMERCIALLY APPROVED 12-12-12 [12% NITROGEN, 12% PHOSPHORIC ACID. AND 12% POTASH BY WBIGHT]. 1/4 OF NITROGEN IN THE FORM OF NITRATES: 1/4 IN THE FORM OF AMMONIA SALT, AND 1/2 IN THE FORM OF ORGANIC NITROGEN.

PROVIDE PRE-MIXED PLANTING MIXTURE FOR USE AROUND THE ROOT BALL/ROOTS OF THE PLANTS CONSISTING OF 5 PARTS TOPSOIL, 1 PART PEAT MOSS, 1 PART MANURE, 10 LBS, FERTILIZER (PER CUBIC TARD), AND 2 1/3 LBS, OF BONE MEAL (PER CUBIC TARD).

PROPOSED ZONE CHANGE SKYLINE CHILI - KENWOOD

SECTION 13, TOWN 4, ENTIRE RANGE 1 SYCAMORE TOWNSHIP, HAMILTON COUNTY, OHIO


LANDSCAPE DETAILS AND NOTES

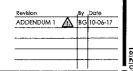

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Engineers - Architects - Surveyors - Landscape Architects - Planners

1'-4"

נספס (תהקלומספסירוטייטיטיש, בל, זט/ס/בטגי מנספינ

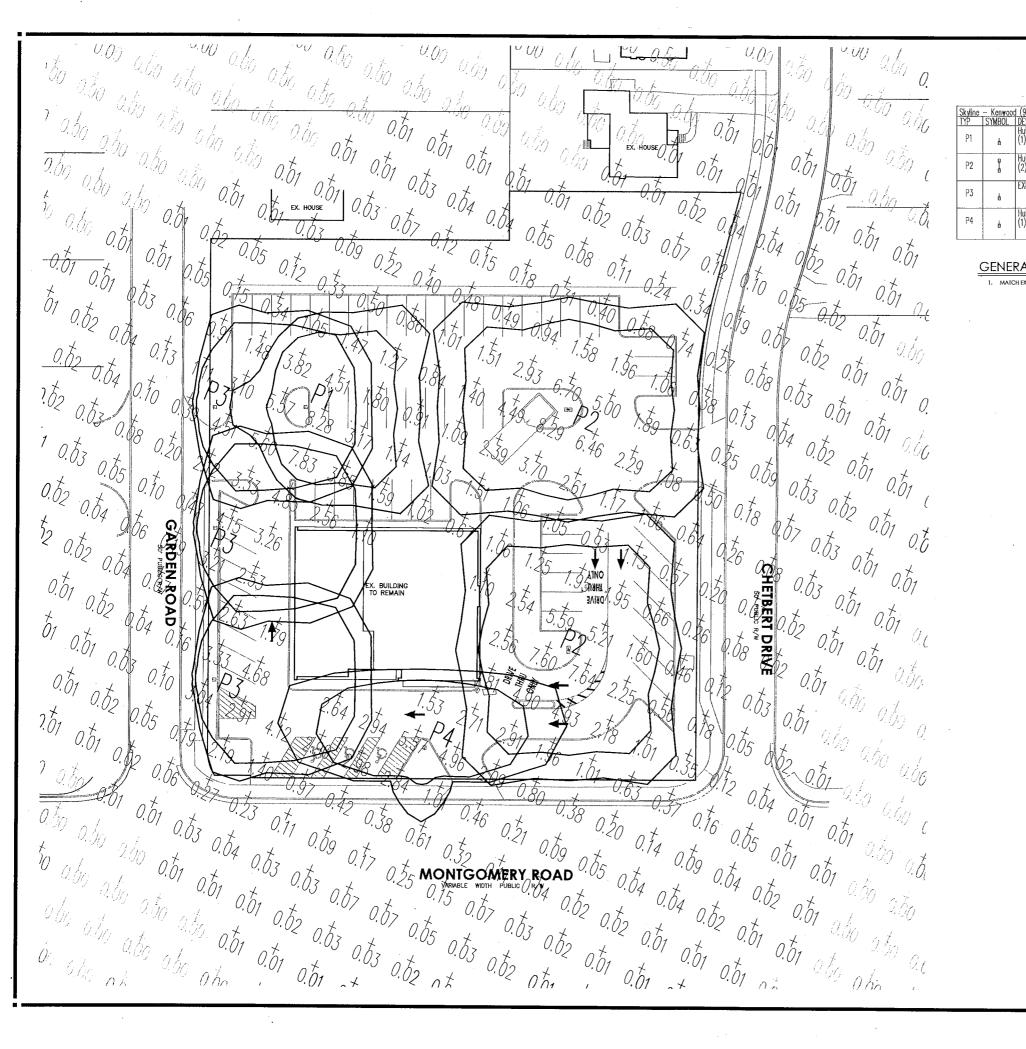

Skyline		1 (9-11-17) LUMINAIRE SCHEDULE					
TYP	SYMBOL	DESCRIPTIÓN	LAMP	LUMENS	MOUNTING/BALLAST	LLF	QTY
P1	4	Hubbell Outdoor Single (1) "A" ASL-24L-4K-210-4	(1)	22260	25' Pole	0.91	1
P2	1	Hubbell Outdoor Double (2) "A" ASL-24L-4K-210-4	(2)	22260	25' Pole	0.91	2
P3	4	EXISTING LIGHT POLE	(1) MS400/H75/ED28PS	40000	25' Pole	0.70	3
P4	6	Hubbell Outdoor Single (1) "C" ASL-24L-4K-210-3	(1)	21935	25' Pole	0.91	1

GENERAL NOTES

. MATCH EXISTING POLE AND FIXTURE.



SKYLINE CHILI - KENWOOD

SECTION 13, TOWN 4, ENTIRE RANGE 1 SYCAMORE TOWNSHIP, HAMILTON COUNTY, OHIO

PHOTOMETRIC PLAN



| Drawn By | BMG | Date | 03/24/17 | Project No. | 16505 00 | Sheet No. | 16505 TBC | CAD | 16505 00 | CAD | CAD | 16505 00 | CAD | C