

PARKING CALCULATION

EXISTING BUILDING:

OFFICE - 2,000 S.F. = 7 SPACES

MANUFACTURING- 31,300 S.F. & 22 EMPLOYEES = 15 SPACES

PROPOSED BUILDING:

WAREHOUSE - 8,550 S.F. = 5 SPACES

EXISTING PARKING: 33 PARKING SPACES REQUIRED PARKING: 27 PARKING SPACES

LIGHT INDUSTRIAL DISTRICT FLOOD DATA COMMUNITY PANEL NO.: 39061C0111E ZONE X

EFFECTIVE DATE: FEBRUARY 17, 2010

WATER AND SANITARY SERVICE ARE EXISTING IN BUILDING

OWNER J&J CEDDIA PROPERTIES LLC 7937 SCHOOL RD CINCINNATI OH 45249

LOT 5 NORDLOHS 1ST INDUSTRIAL 600-0013-0009-00





IMPERVIOUS SURFACE=64257.94 LOT AREA=87443.65 ISR=74%

SEDIMENTATION CONTROL NOTES:

The project has been designed to control erosion and prevent damage to any adjacent property. All stripping, earthwork, and re—grading shall be performed to minimize erosion. Natural vegetation shall be retained weherever possible. The proposed plan will allow almost all eroded materials to be retained on site.

Sediment Ponds/Traps and Perimeter Controls shall be implemented as a first step of grading and within 7 days from the start of grubbing and shall continue to function until upland areas are stabilized.

Disturbed areas which will remain un—worked for a period of 21 days or more, shall be stabilized with seeding and mulching or other approved means within 7 days. All disturbed areas within 50 feet of an intermittent or solid blue line stream (as defined by USGS 7.5" Quadrangles) shall be stabilized within two (2) days. All areas of a site which are at a final grade shall be stabilzed with seeding and mulching or other approved means within seven (7) days.

Ditches with grades greater than 1.5% and all other slopes greater than 6% will have erosion control blankets/matting installed as one of the soil stabilization measures.

The builder is responsible for erosion control on each individual lot. NPDES permit coverage must be maintained on each lot until it reaches final stabilization.

No solids or liquid waste shall be discharged into storm water runoff.

All erosion and sediment control practices must conform to the specifications of Rainwater and Land Developement: Ohio's standard for Storm Water Management, Land Developement and Urban Stream Protection.

Regular inspection and maintenance will be provided for all erosion and sediment control practices. Permanent records of Maintenance and inspections must be kept throughout the construction period. Inspections must be made a minimum of once every 7 days and immediately after storm events greater than 0.5 inches of rain in a 24 hour period. Inspection logs must provide the name of the inspector, major observations, date of inspection, and corrective measures taken.

Erosion control as it is shown on the grading plan is at a minimum. The contractor shall be responsible for the installation of any additional erosion control required by the City of Fairfield. It will be the responsibility of the contractor to insure that the proper measures are taken to avoid damage to the adjacent properties.

The contractor or owner's representative shall be responsible for erosion control inspections and documentation as required by the NPDES permit.

GENERAL NOTES

A MIN. DEPTH

GENERAL NOTES

OF 3'-0".

NOTE: VAN ACCESSIBLE SIGN TO BE

1. U-TYPE FLANGED STEEL

SIGN POST. SET IN

A. 18"x 12"x 16 GA.

B. 9"x 12"x 16GA.

INSTALLED ON MINIMUM ONE SIGN.

STEEL HANDICAP SIGN

STEEL HANDICAP SIGN

HANIDCAP SIGN DETAIL

PARKING ONLY

10440.B

(1 SIGN TO READ

"VAN ACCESSIBLE")

NOTE #1

MAXIMUM FINE

\$500

CONCRETE DETAIL

GENERAL NOTES

ELEVATIONS SHOWN ON THE PLOT PLAN.

APPROVAL OF THE OWNER.

8. <u>DOWN SPOUT NOTE</u>

WITH SUITABLE COMPACTED FILL.

3. FOLLOW WRITTEN DIMENSIONS ALWAYS. DO NOT SCALE.

7. SEE ARCHITECTURAL DRAWINGS FOR BUILDING DIMENSIONS

ROOF DOWN SPOUTS FROM THE PROPOSED BUILDING ARE TO DISCHARGE TO EXISTING SWALE

4. ADJUSTMENTS TO GRADE MAY BE ALLOWED TO PROVIDE A BALANCED SITE. NO ADJUSTMENT TO GRADE ARE ALLOWED WITHOUT THE PRIOR


5. REMOVE EXISTING TOP SOIL FROM AREAS TO BE PAVED AND REPLACE


CONCRETE DRIVEWAY/PARKING LOT 6"ODOT ITEM 452

ODOT ITEM 204

SUBGRADE COMPACTION


TO BE INSTALLED @ ALL H/C SPACES

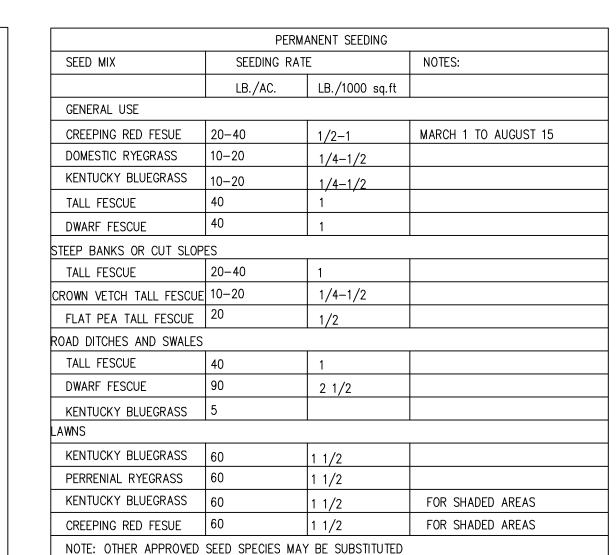

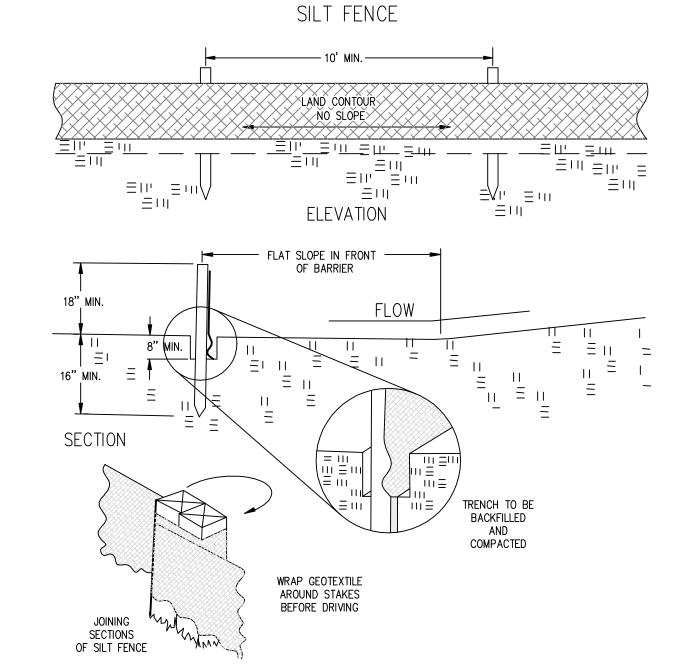

Plastic liner min. 10 mil

SPECIFICATIONS

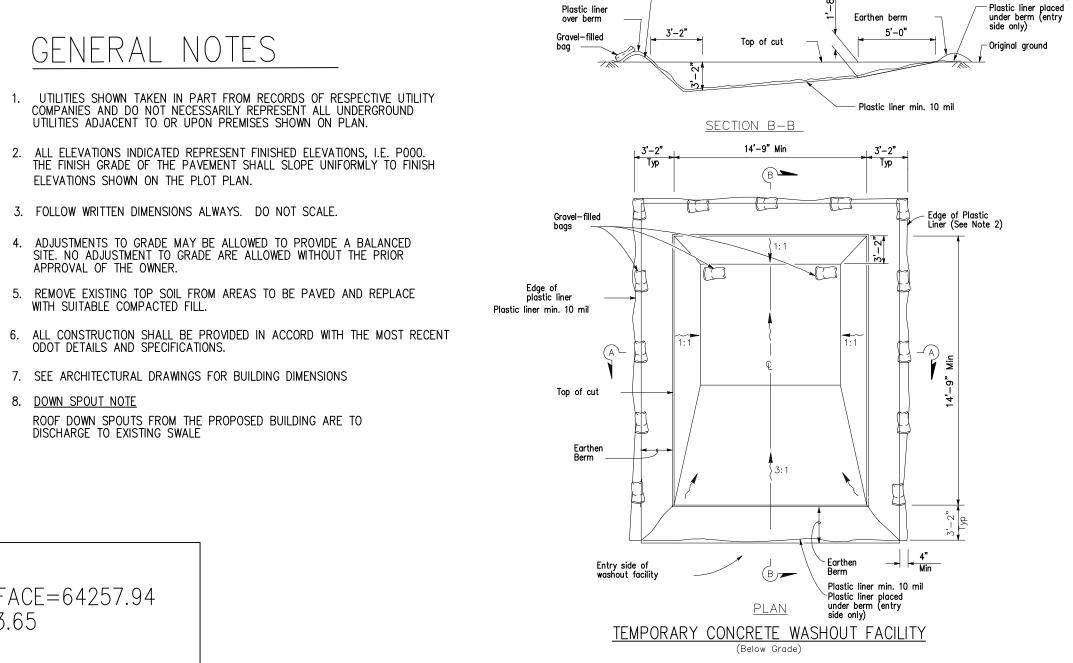

Earthen berm


Issue Dates

SITE & GRADING

Drawn by: |Checked by

3/15/18 | AMERICRAF1 DRAWING NO.

2 WORKING DAYS BEFORE YOU DIG UTILITIES PROTECTION SERVICE FESMA

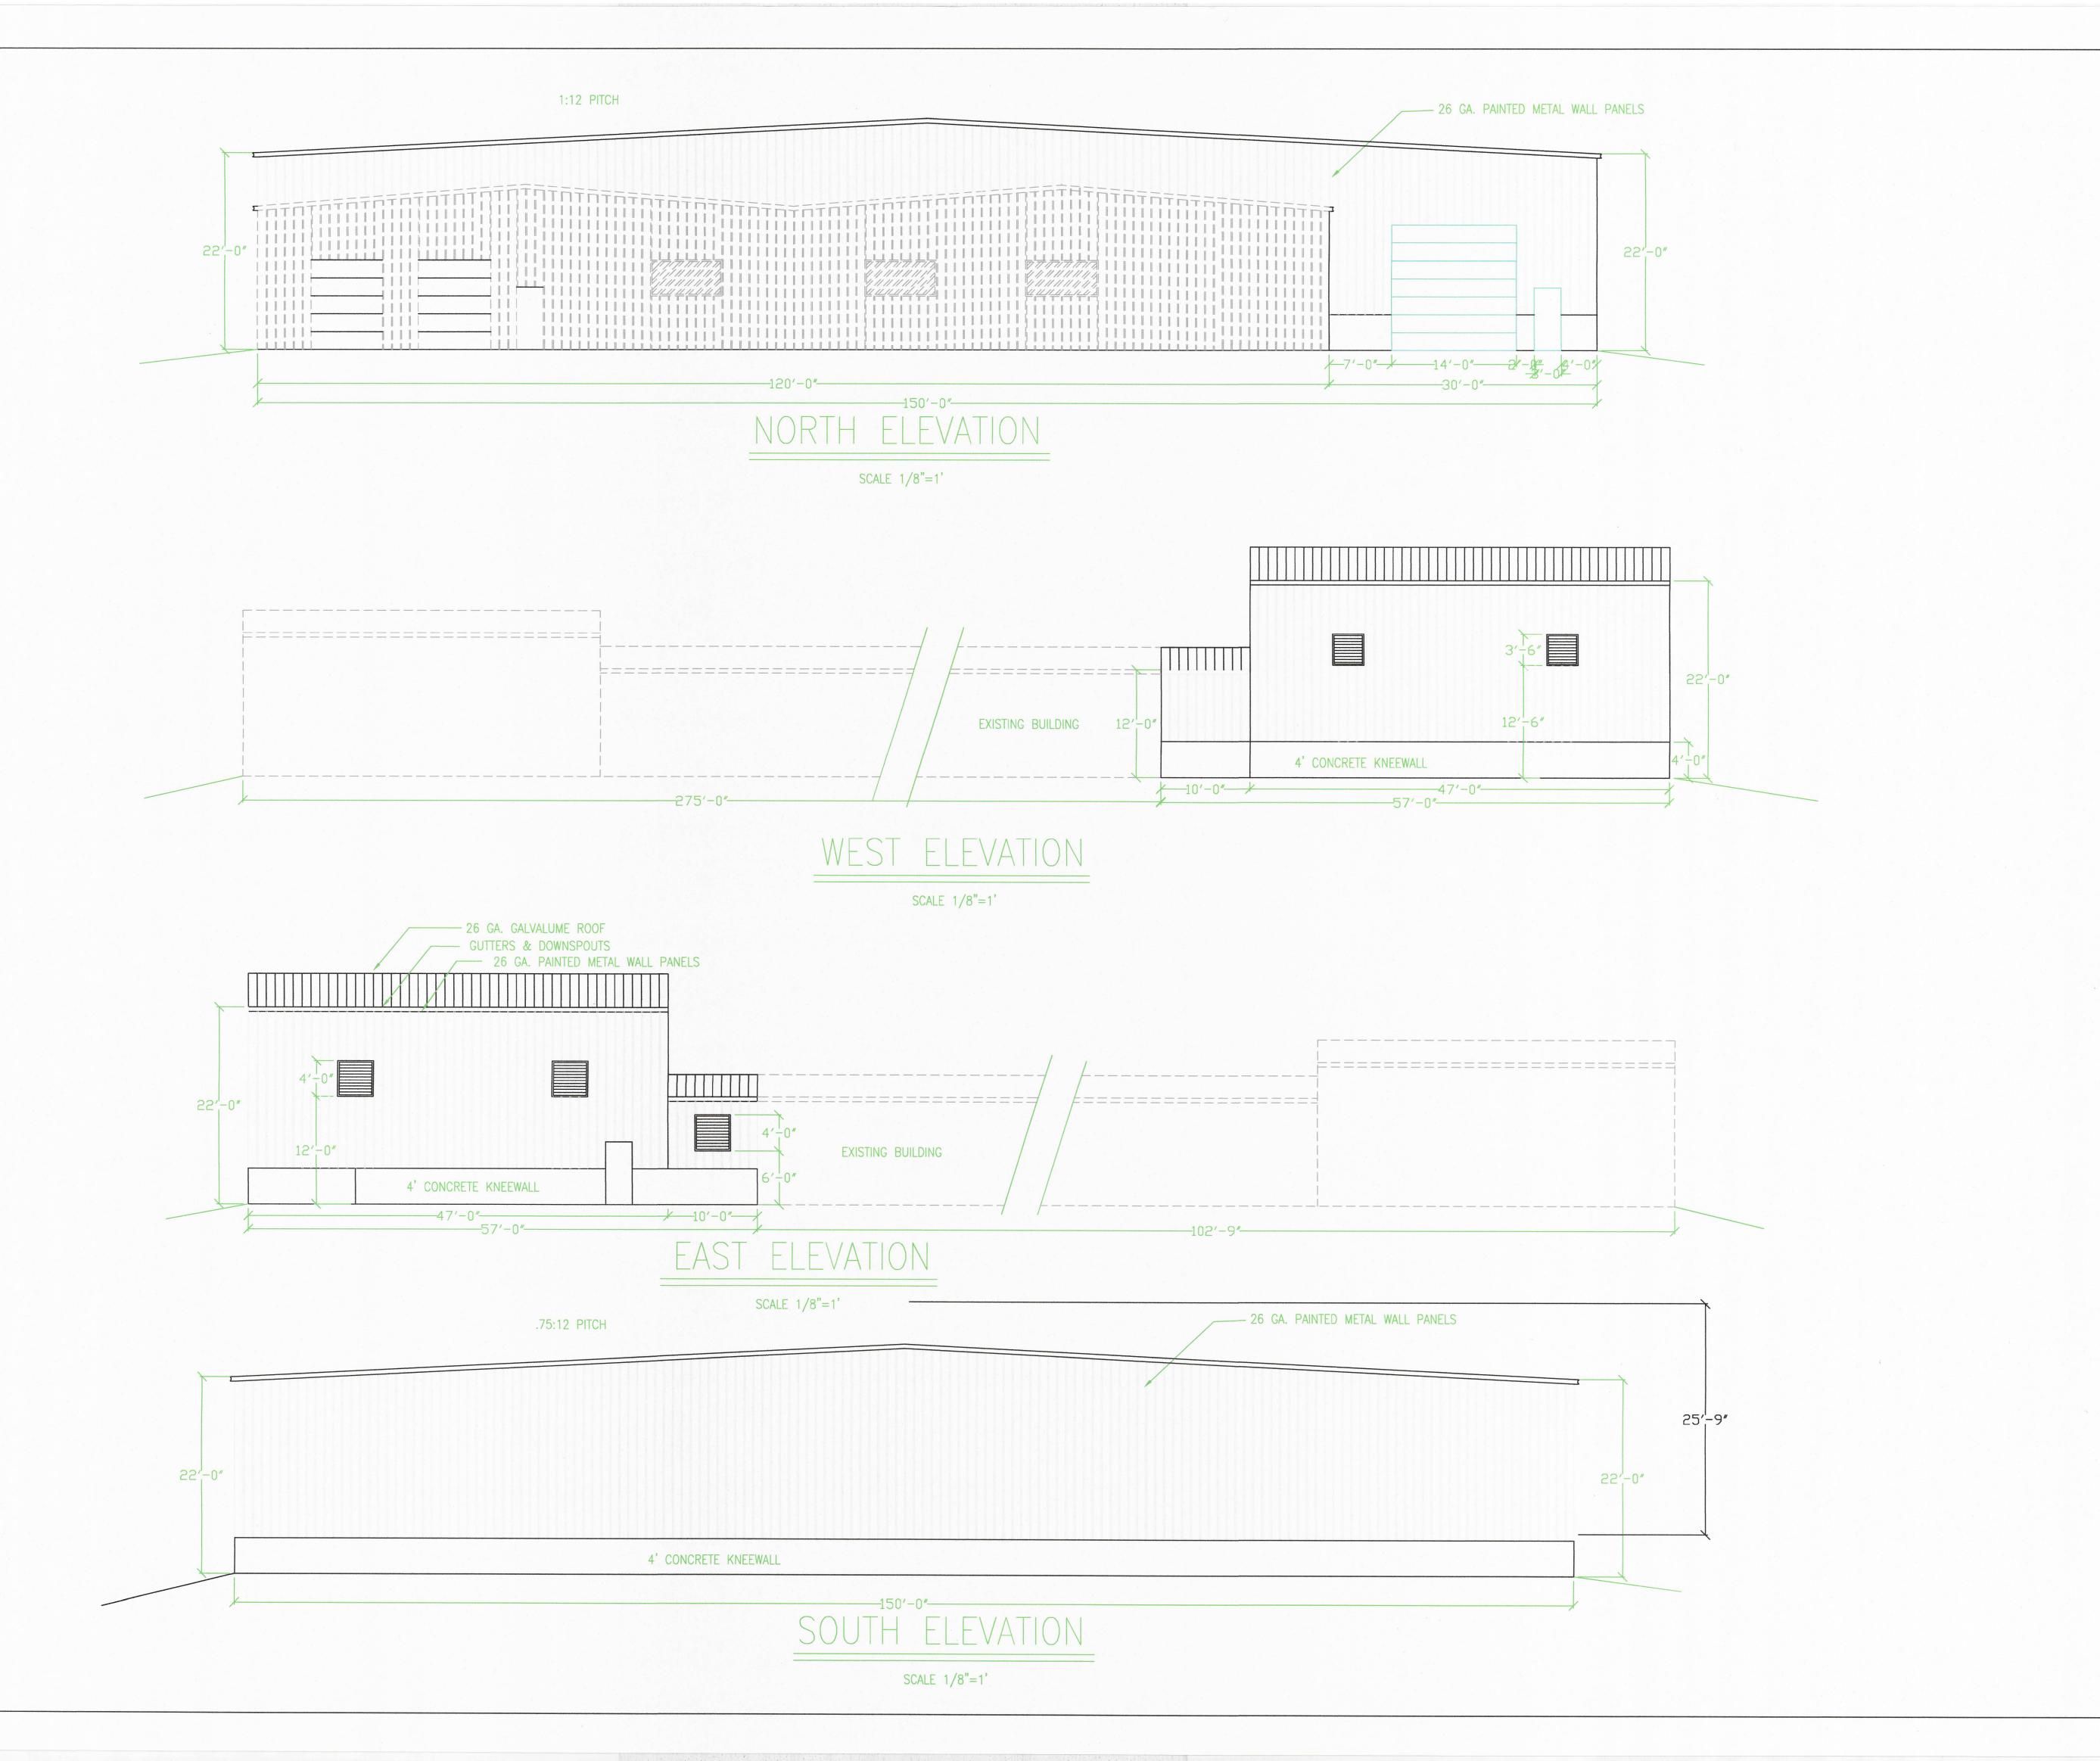



RACTING INC.

STRUCTURAL CONTR

ACTOR H&H STRU

AMERICRAFT

SCALE: 1/8 := 1/

ELEVATIONS

SCALE: 1/8"=1'


DRAWN BY:

GARY HART

CHECKED BY:


TE: 2-1-2018

SHT.

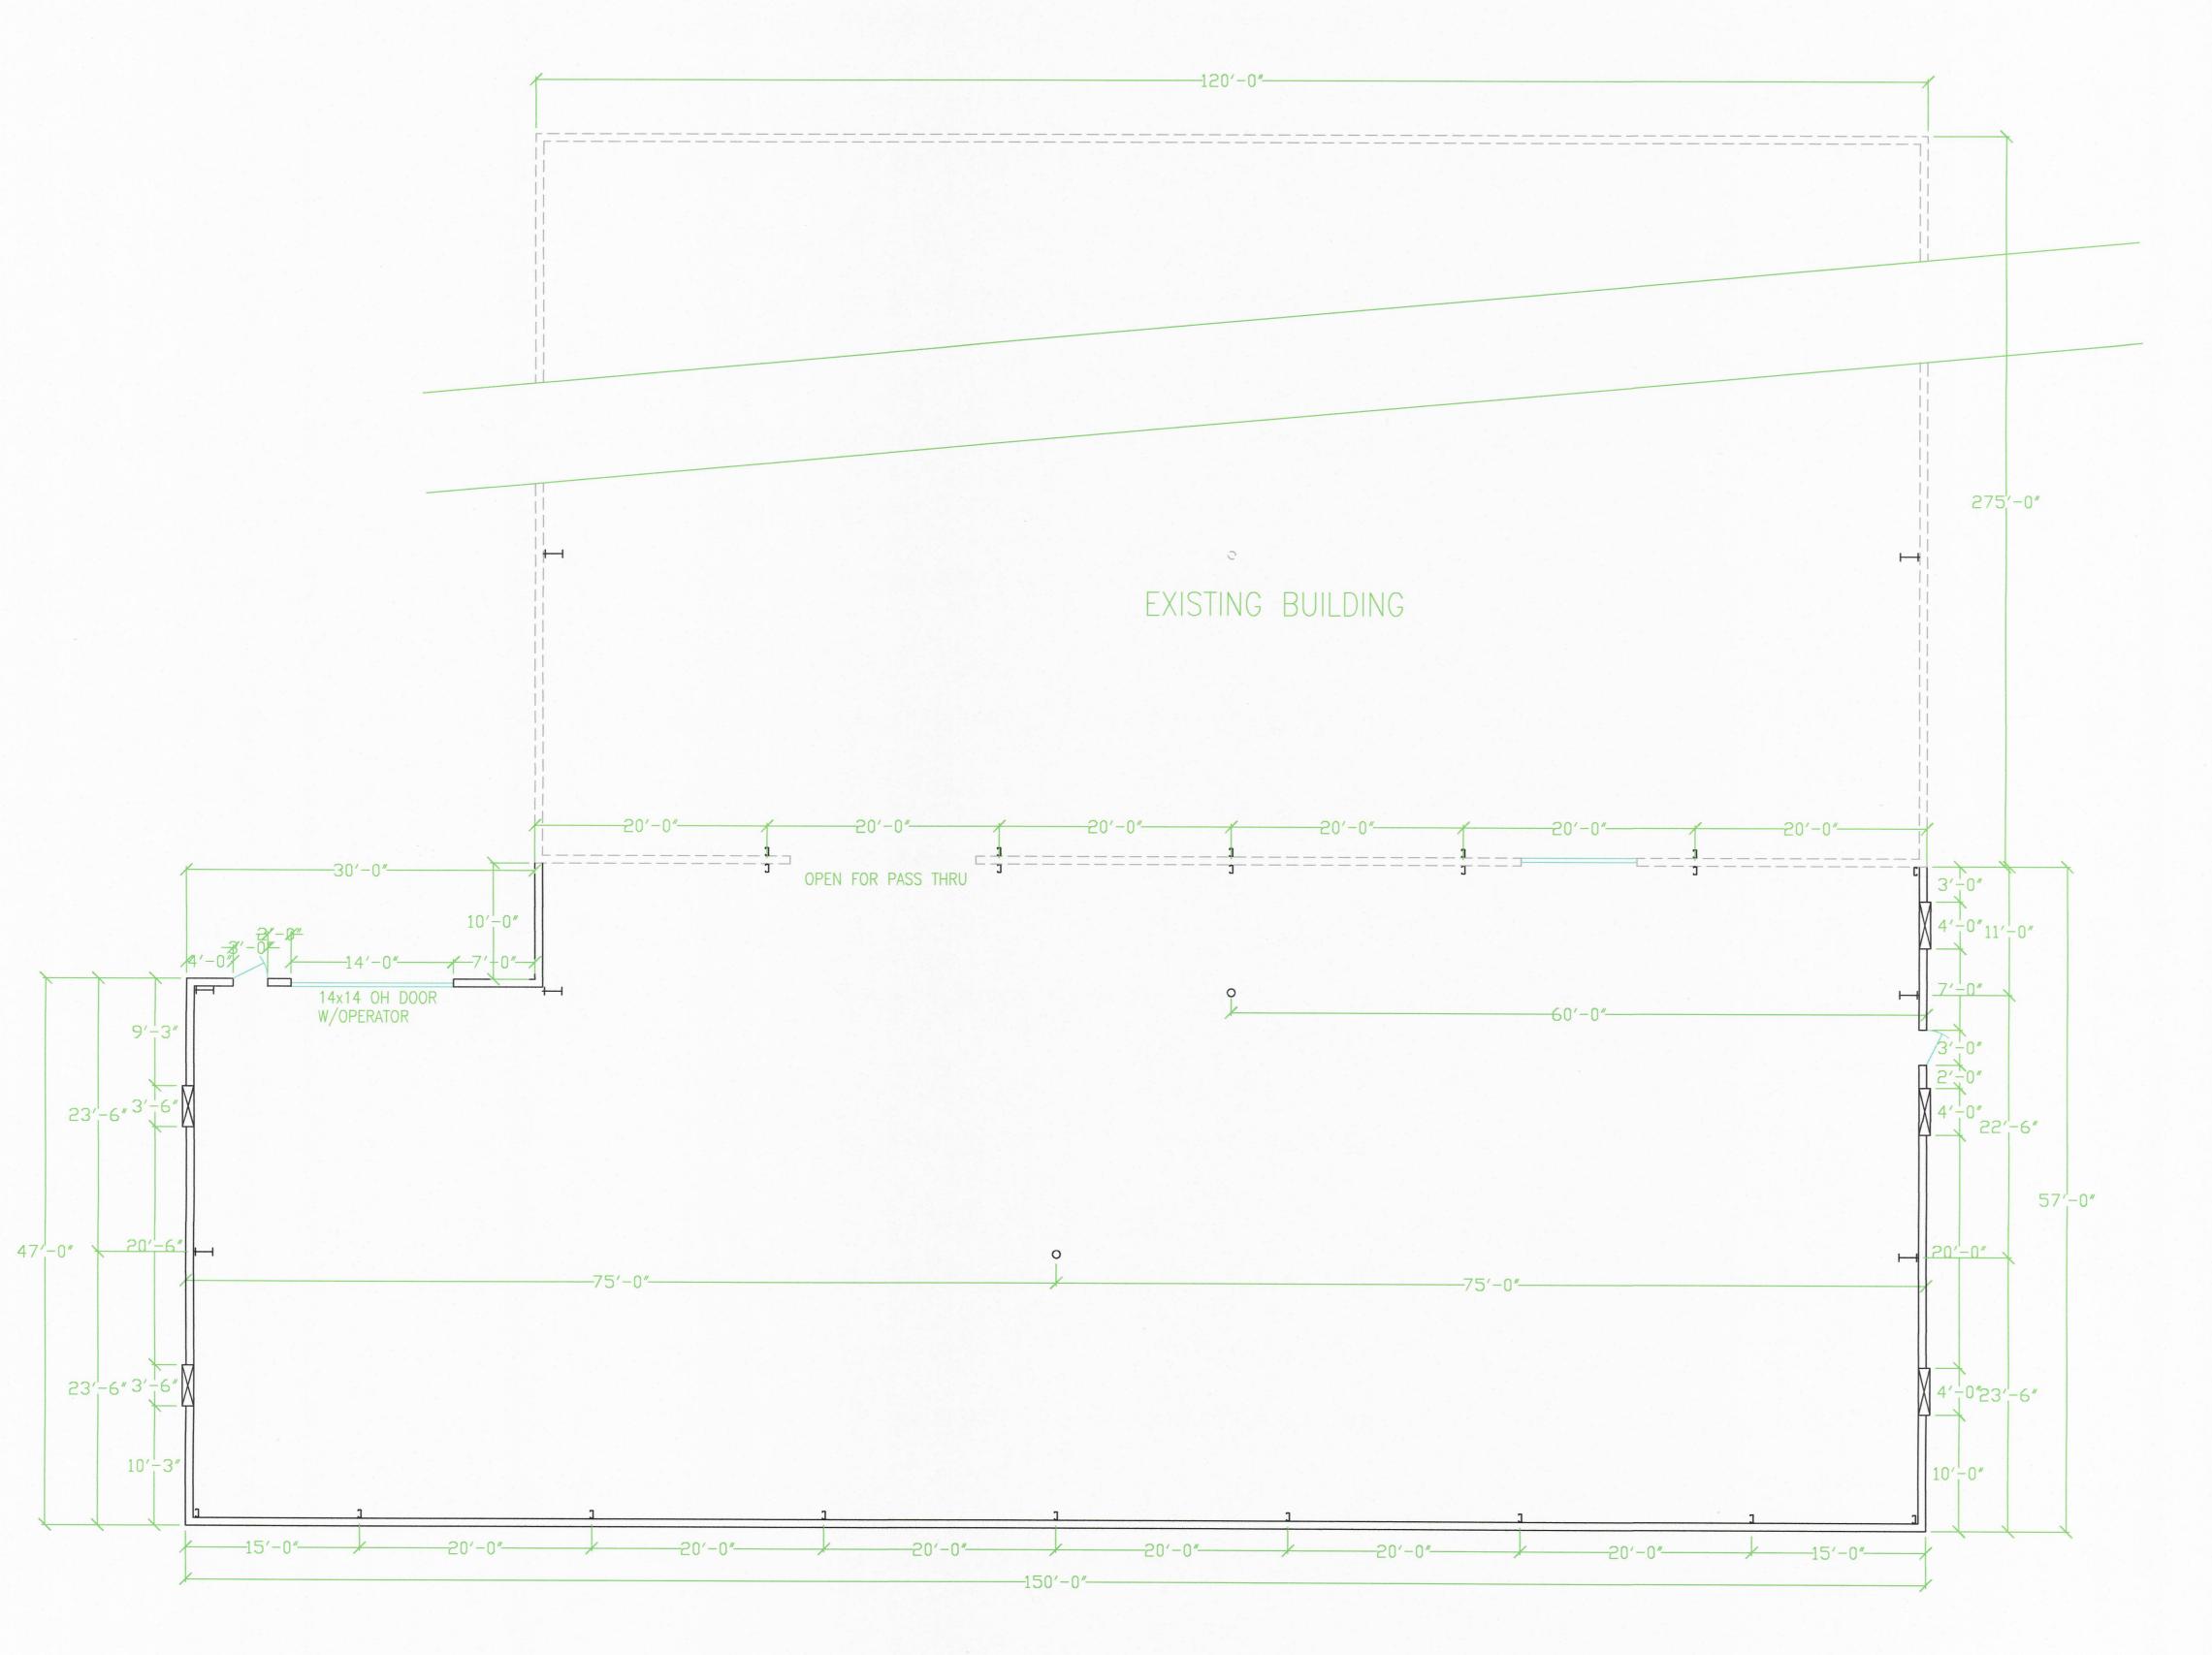

FLOOR PLAN

SCALE 1/8"=1'

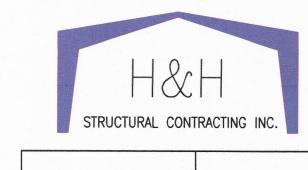

AMERICRAFT

SHEET TITLE:
FLOOR
SCALE: 1/8"=1'

DRAWN BY: GARY HART

CHECKED BY: DATE: 2-1-2018

SHT. NO. A 1